DRAWING LIST

SHEET	DRAWING TITLE	SCALE
L-0.00	COVER SHEET	
L-1.00	OVERALL SITE PLAN	1:200
L-1.01	WEST PLAN	1:120
L-1.02	EAST PLAN	1:120
L-1.03	SOUTH PLAN	1:120
L-2.01	PLANTING PLAN	1:200
L-3.01	SECTIONS	AS SHOW
L-4.01	DETAILS	AS SHOW
L-4.02	DETAILS	AS SHOW
L-4.03	DETAILS	AS SHOW
	-	

GENERAL NOTES

- 1. Refer to architectural drawings for all walls and stair layout and elevations, unless otherwise
- 2. Refer to electrical drawings for all final landscape lighting layout and specifications.
- 3. Refer to architectural and mechanical drawings for all drain locations and rim elevations.
- 4. Refer to arborist drawings for all tree retention / removal information.
- 5. Refer to civil drawings for all grading and utility information.
- 6. Refer to survey drawings for all existing on site services and survey symbols.
- 7. City trees exact number and locations, species and size to be determined by City of Nanaimo Public Works Department contact at public.worksinfo@nanaimo.ca

PRODUCT + MATERIAL NOTES

- 1. All materials to be as specified or pre-approved equivalent.
- 2. All material and products to be installed per manufacturer's specifications.


LANDSCAPE NOTES


- 1. All work shall meet or exceed the requirements as outlined in the current Edition of the Canadian Landscape Standard.
- 2. Plant sizes and related container classes are specified according to the Canadian Landscape Standard current Edition. For container classes #3 and smaller, plant sizes shall be as shown in the plant list and the Standard; for all other plants, both plant size and container class shall be as shown in the plant list. Specifically, when the plant list call for #5 class containers, these shall be as defined in the CNLA (ANSI) Standard.
- 3. Area of search for specified plant material shall include the Lower Mainland of British Columbia, Vancouver Island, Washington and Oregon States.
- 4. Contractor shall source specified plant material and only after area of search has been exhausted will substitutions be considered.
- 5. All plant material used on this project shall be hardy in this climate. Plant types have been selected with this as a primary criteria. This Contractor shall guarantee that plant material supplied has equal provenance, ie: it is developed from cuttings or seeds collected in an area of similar climatic characteristics.
- 6. Substitutions in plant material will not be considered unless written proof is submitted thirty (30) days prior to scheduled installation stating a specified plant cannot be obtained within the specified area of search.
- 7. All plants to be sourced from nurseries certified free of P. ramorum.
- 8. Contractor shall not move or work growing medium or additives when they are excessively wet, extremely dry, or frozen or in any manner which will adversely affect growing medium structure. Growing medium whose structure has been destroyed by handling under these conditions will be rejected. Growing medium shall not be handled in wet or frozen conditions.
- 9. Place growing medium, except structural to required finish grades and minimum depths as detailed, unless shown otherwise.
- 10. All growing medium placed on project to meet or exceed BCNTA and Canadian Landscape Standards latest edition.
- 11. All trees to be staked in accordance with CNLA Standards.
- 12. Submit sieve analysis by an approved independent soil testing laboratory for each type of growing medium being used on the project PRIOR to placement for review and approval. Clearly identify source and type for each. Resubmit as required until growing medium is
- 13. Submittals shall be made at least seven (7) days before

IRRIGATION NOTES

- All 'Soft Landscape Areas' are to be irrigated with a high efficiency design/build irrigation system, complete with Rain and Wind Sensor.
- The irrigation system design and installation shall be in accordance with the Irrigation Industry of BC Standards and Guidelines.
- System design and installation shall take into account elevation differences, sun orientation and other factors affecting zoning and operation of the system to minimized evapotranspiration and wind lost.
- 4. System design shall provide for uniform complete 'Head to Head' coverage of all lawns and
- 5. Contractor shall be responsible to provide SHOP DRAWINGS a minimum of 3 weeks prior to installation of any irrigation for review and approval.
- Should the contractor proceed without approval, any additional modifications to the irrigation systems, as directed by the Landscape Architect shall be at at contractors cost.
- 7. Lawns shall be irrigated on separate zones from planted areas.
- 8. Controller shall be located in mechanical room.
- PRIOR to Substantial Performance, contractor shall provide a maintenance data and Operation instruction manual containing operational information for all operating components, cleancing and lubrication schedules, overhaul/adjustment schedule.
- 10. Record Drawings: Submit with the operating and maintenance manuals a reproducible copy of the AS-BUILT condition of the system.
- 11. Contractor shall instruct a designated representative of the Owner in the complete operating and maintenance procedures for the irrigation system, including winterizing for the fist time with the designated representative observing.
- 12. Use GSR Schedule 40 PVC designed for solvent welding to PVC pipe except where valves, risers, etc. require threaded joints.
- 13. Provide sleeves under all hard surfaces and as required through walls.
- 14. Solenoid valves shall be first quality, compatible with the controller selected.
- 15. Valve boxes shall be reinforced plastic boxes manufactured specifically for landscape irrigation, complete with captive lock bolt cover, sized to suit valves and other components with adequate room for operation and maintenance.

MATERIALS LEGEND

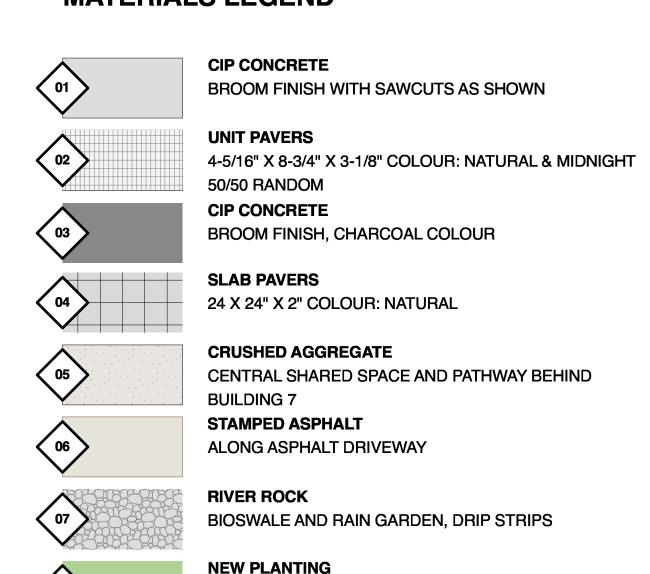

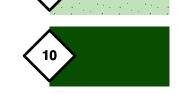

(80

HEDGES
REFER TO PLANT LIST

SODDED LAWN

REFER TO PLANT LIST

FURNISHINGS LEGEND

01	

WOOD BENCHES
CUSTOM DESIGN



BIKE RACK







MAGLIN 600 SERIES
PLAZA TABLE SEATING

MAGLIN FAVA CLUSTER SEATING

MAGLIN ICONIC BIKE RACK



05

MAGLIN FORO TABLE AND CHAIR



BOULDERGRIZZLY GRANITE



STRIP LIGHT SELUX PEETA



LIGHTING BOLLARD SELUX INULA


PLANT LIST

TREES				
SYMBOL	QTY	BOTANICAL NAME	COMMON NAME	SIZE / SPACING
	9	Acer circinatum	Vine Maple	5cm cal., B&B
	3	Acer macrophylla	Big Leaf Maple	6cm cal, B&B
	7	Acer rubrum	Red Maple, Swamp Maple	6cm cal., B&B
	4	Alnus rubra	Red Alder	6cm cal, B&B
×a	3	Catalpa speciosa	Northern Catalpa	7cm cal., B&B
	10	Cornus kousa	Kousa Dogwood, Japanese Dogwood	6cm cal, B&B
\odot	14	Magnolia x 'Butterflies'	Butterflies Magnolia	6cm cal., specimen
	3	Malus x domestica 'Red Delicious'	Red Delicious Apple	5cm cal, 10 gal pot
A CONTRACTOR OF THE PARTY OF TH	1	Prunus x 'Bing Cherry'	Bing Sweet Cherry	5 cm cal, 10 gal pot

SHRUBS				
SYMBOL	QTY	BOTANICAL NAME	COMMON NAME	SIZE / SPACING
Aw	81	Azalea 'Gumpo White'	Gumpo White Azalea	#2 Pot / 24" O.C.
Bt	17	Berberis thunbergii	Japanese Barberry	#1 pot / 12" O.C.
Ct	7	Choisya ternata	Mexican Orange Blossom	#2 pot / 24" O.C.
Ew	106	Erica carnea 'Springwood White'	Springwood White Heather	#1 pot / 16" O.C.
Gs	100	Gaultheria shallon	Lemon Leaf	#2 pot / 24" O.C.
Ну	10	Hydrangea arborescens 'Annabelle'	Annabelle Hydrangea	#3 pot, 36" o.c.
Lb	105	Lavandula angustifolia 'Blue Cushion'	Blue Cushion Lavender	#2 pot / 24" O.C.
Lp	120	Lonicera Pileata	Privet honeysuckle	#2 pot / 42" O.C.
Mn	40	Mahonia nervosa	Longleaf Mahonia	#2 pot / 24" O.C.
Rs	23	Ribes sanguineum	Red Flowering Currant	#3 pot, 36" o.c.
Sc	39	Sarcococca confusa	Sweet Box	#2 pot / 24" O.C.
Sb	33	Spiraea betulifolia 'Tor'	Tor Birchleaf Spirea	#2 pot, 30"o.c.
Т	48	Taxus x media 'Hillii' (Male Plants Only)	Hill's Yew	4' ht, B&B, 18" O.C
Vb	22	Viburnum davidii	David Viburnum	#2 pot/ 30" O.C.

GROUNDCOVERS, GRASSES, FERNS & VINES

31100HD00	riconbooverio, arbacec, reinto a vineo				
SYMBOL	QTY	BOTANICAL NAME	COMMON NAME	SIZE / SPACING	
Cm	215	Carex morrowii 'Ice Dance'	Ice Dance Japanese Sedge	#1 pot / 12" o.c.	
Ēp	41	Echinacea purpurea	Purple Coneflower	#2 pot / 24" O.C.	
!	13	Festuca glauca 'Elijah Blue'	Blue Fescue	#1 pot, 12"o.c.	
Hs	137	Helictotrichon sempervirens	Blue Oat Grass	#2 pot / 30" O.C.	
На	173	Heuchera 'Amber Waves'	Amber Waves Coral Bells	#1 pot, 12"o.c.	
s	5	Iberis sempervirens	Evergreen Candytuft	#1 pot / 14" O.C.	
⊃ c	52	Polystichum munitum	Hard Shield Fern	#2 pot / 30" O.C.	
Ss	26	Sedum spathufolium 'Purpureum'	Broad-Leaved Stonecrop	4"(10cm) pot	
St	149	Stipa tenuissima	Mexican Feather Grass	#2 pot / 24" O.C.	

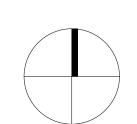

2	2025-07-08	Issue for DP	MP	
l	2025-07-04	Issue for DP Draft	MP	
10.:	date:	item:	by:	

Revisions:
Stamp:





P 604.684.4611 | F 604.684.0577 | www.dkl.bc.ca

Client:

RECEIVED
DP1392
2025-JUL-16
Current Planning

Project:

3397 Tunnah Road

3397 Tunnah Road, Nanaimo, BC V9T 2V8

Drawn by:	MP
Checked by:	SV
Date:	2025-04-28
Scale:	1:200

Drawing Title:


COVER SHEET

Project No.:
25025
Sheet No.:

L-0.00





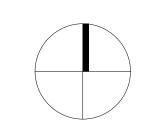

no.:	date:	item:	by:
1	2025-07-04	Issue for DP Draft	MP
2	2025-07-08	Issue for DP	MP

Revisions:
Stamp:





P 604.684.4611 | F 604.684.0577 | www.dkl.bc.ca

Client:

RECEIVED
DP1392
2025-JUL-16
Current Planning

Project:

3397 Tunnah Road

3397 Tunnah Road, Nanaimo, BC V9T 2V8

Drawn by: MP

Checked by: SV

Date: 2025-04-28

Scale: 1:120

Drawing Title:


WEST PLAN

Project No.: **25025**

Sheet No.:


L-1.01



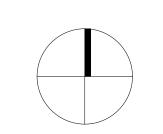

2 2025-07-08 Issue for DP MP
1 2025-07-04 Issue for DP Draft MP
no.: | date: | item: | by:

Stamp:

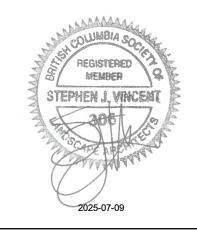

DURANTE KREUK LTD. LANDSCAPE ARCHITECTS
102 - 1637 West 5th Avenue Vancouver B.C. V6J 1N5

P 604.684.4611 | F 604.684.0577 | www.dkl.bc.ca

Client:

RECEIVED
DP1392
2025-JUL-16
Current Planning

Project:

3397 Tunnah Road

3397 Tunnah Road, Nanaimo, BC V9T 2V8

Drawn by: MP

Checked by: SV

Date: 2025-04-28

Scale: 1:120

Drawing Title:

EAST PLAN

Project No.: **25025**

Sheet No.:

L-1.02







DURANTE KREUK LTD. LANDSCAPE ARCHITECTS
102 - 1637 West 5th Avenue Vancouver B.C. V6J 1N5

P 604.684.4611 | F 604.684.0577 | www .dkl.bc.ca



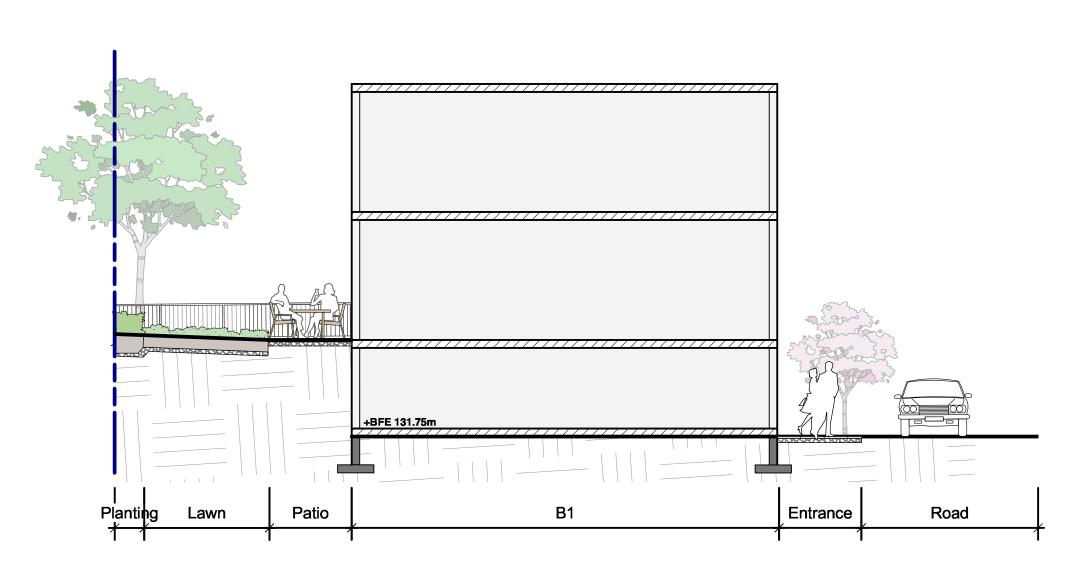



Section Through Building 1
L-3.01 Scale = 1:96

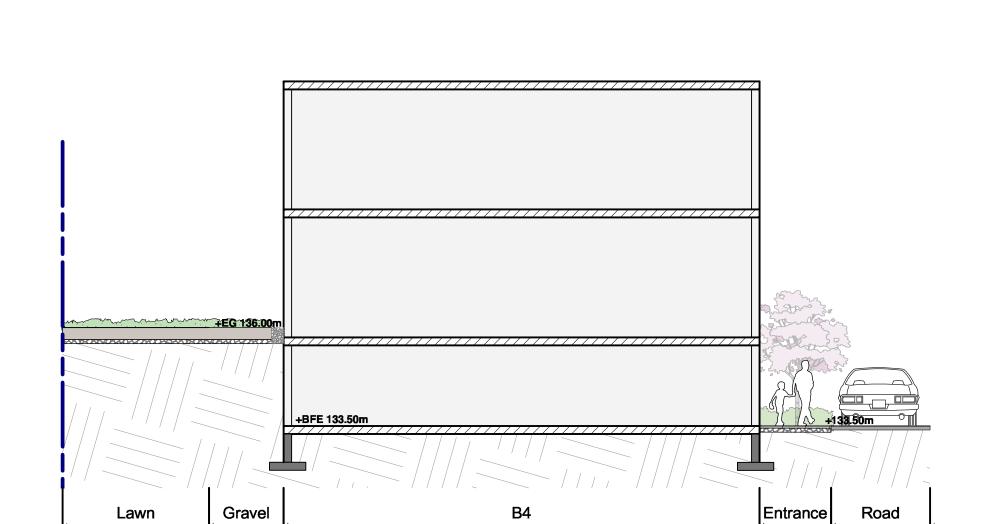


Section Through Building 4

L-3.01 Scale = 1:96

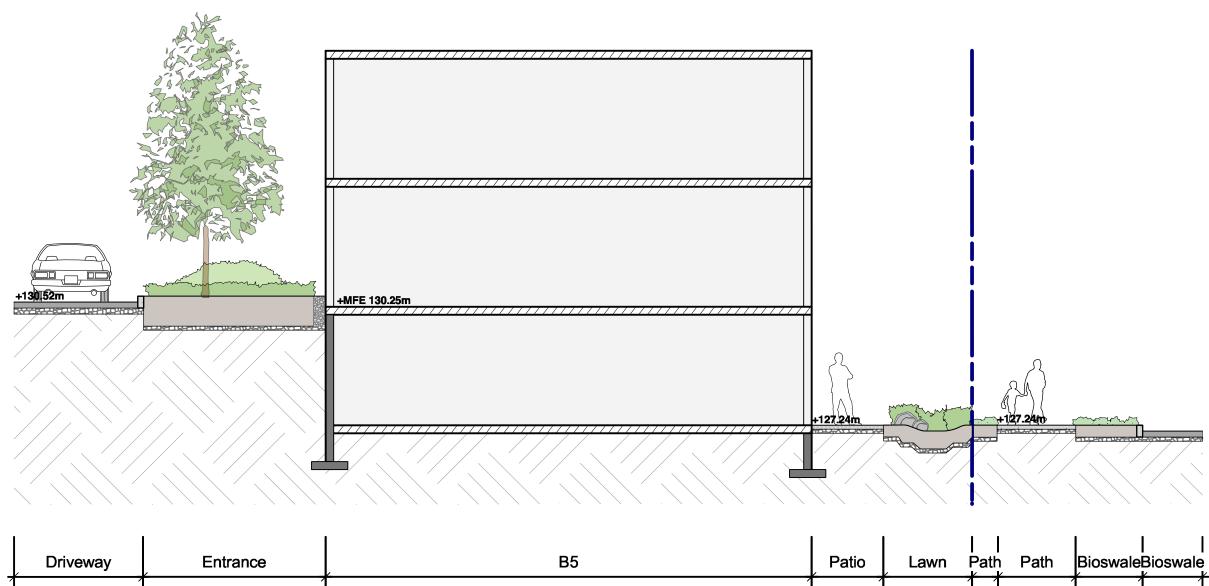

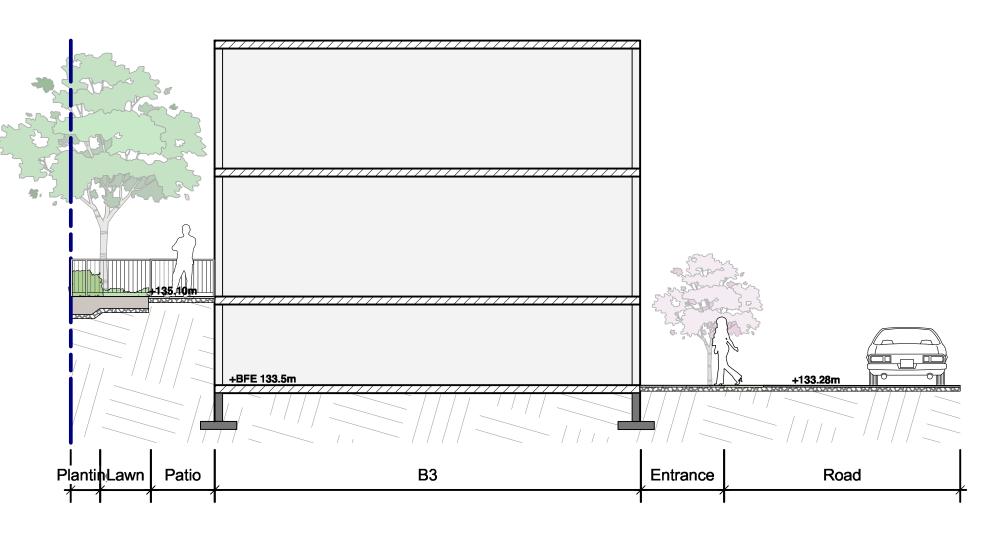


2 Section Through Building 3
L-3.01 Scale = 1:96

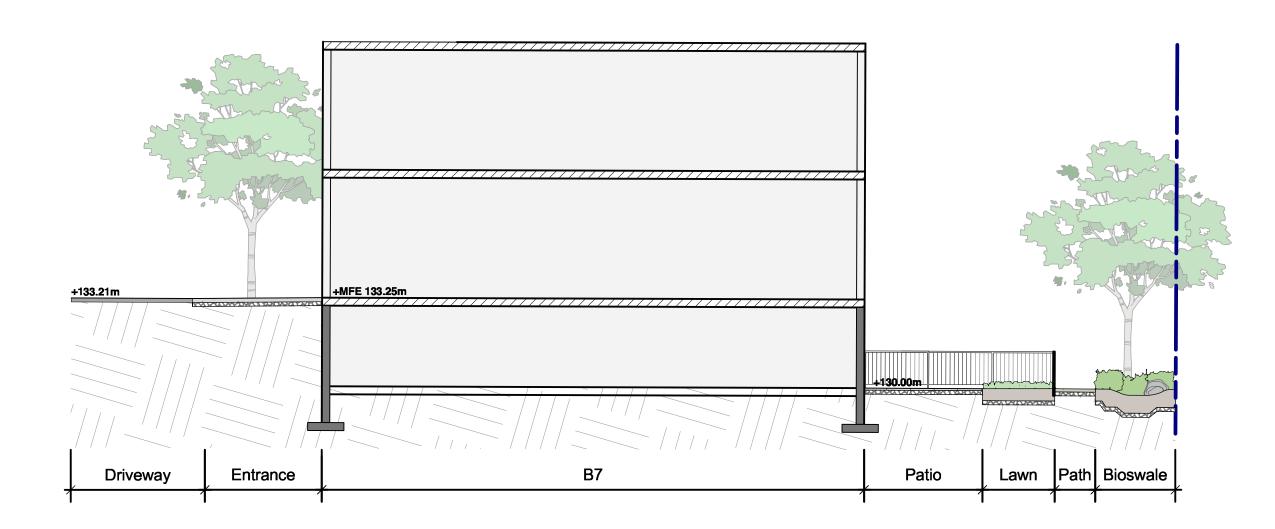

4 Section Through Building 7

Scale = 1:96

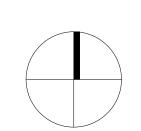

2 2025-07-08 Issue for DP MP
1 2025-07-04 Issue for DP Draft MP
no.: | date: | item: | by:

Stamp:



DURANTE KREUK LTD. LANDSCAPE ARCHITECTS
102 - 1637 West 5th Avenue Vancouver B.C. V6J 1N5
P 604.684.4611 | F 604.684.0577 | www.dkl.bc.ca

Client:

RECEIVED
DP1392
2025-JUL-16
Current Planning

Project:

3397 Tunnah Road

3397 Tunnah Road, Nanaimo, BC V9T 2V8

Drawn by: MP

Checked by: SV

Date: 2025-04-28

Scale: AS SHOWN

Drawing Title:


SECTIONS


Project No.: 25025


Sheet No.:


L-3.01

Section Through Building 5
L-3.01 Scale = 1:96

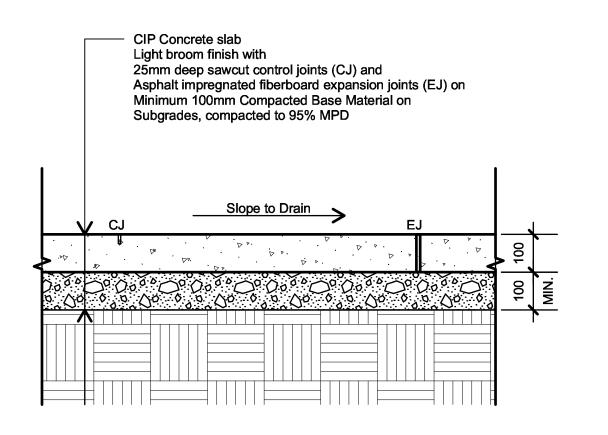

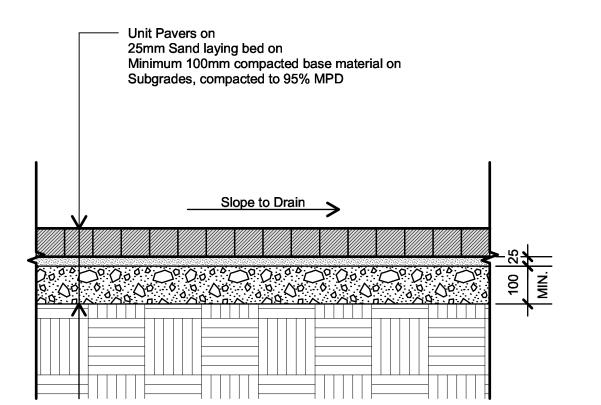

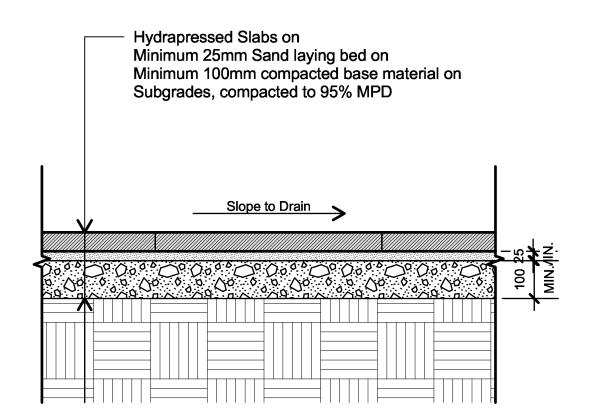

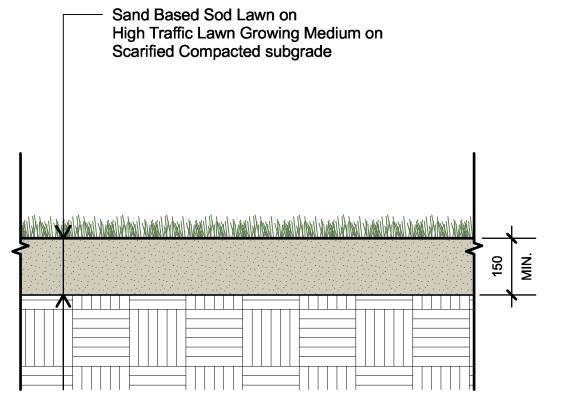

CIP CONCRETE - ON GRADE

5 PLANTING - ON GRADE


UNIT PAVERS - ON GRADE

HYDROPRESSED SLABS - ON GRADE


TREE PLANTING NOTES

on tree pit centreline. 2. Do not cut Tree Leader. SOD LAWN - ON GRADE

50mm Well Composted Mulch on Min. 450mm Type III Growing Medium on Scarified, free draining subgrade

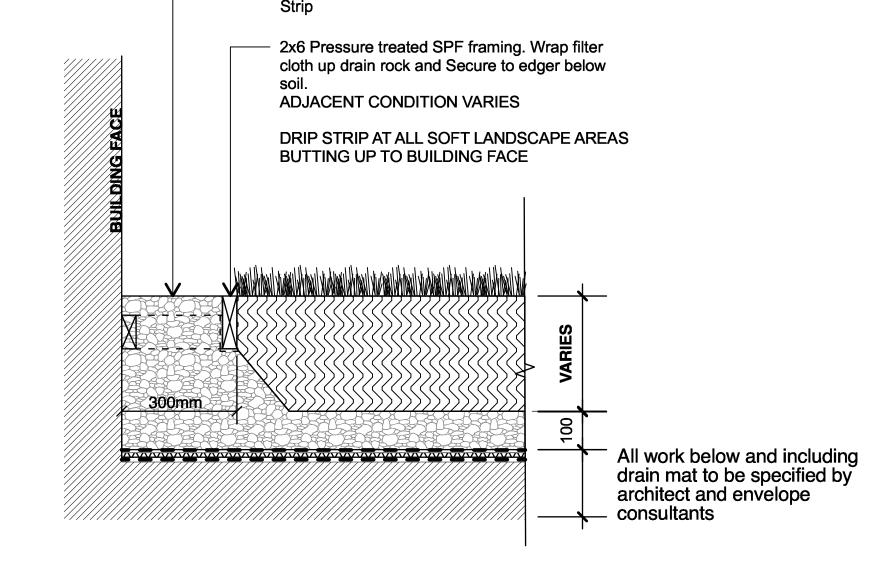

300mm Wide 3/4" Rounded Drain Rock

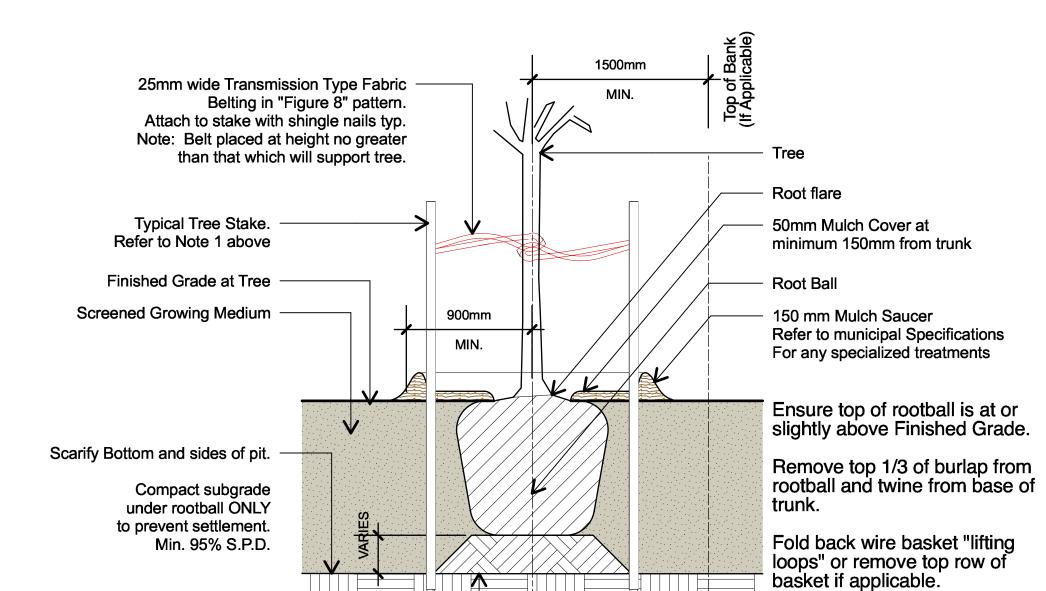

1. All street trees to be staked with 2 - 100mmØ x 2.5m long. Minimum depth of stake embedment is 1m. Ensure stakes do not penetrate or damage rootball. Ensure all stakes are aligned parallel to sidewalk/road


4. Protect tree from damage during planting. Ensure rootball protected from Sun, Frost or Desiccation.

3. Ensure tree location does not conflict with Underground Services. "Call before digging".

5. Provide min. 5 cubic meters of growing medium per tree, unless otherwise stated.

6. Refer to Growing Medium Chart below for surface area depth of Growing Medium.

of 9mm minus crusher dust trail linimun 6" Compacted Base Material ypical for all trail material on ubgrade, compace to 95% MPD	Ensure unobstructed drainage pattern through length of swale running parallel to path.'
	If drainage is required to cross the path, pipe to be installed below trail so that no over land flow crosses the path.
Slope to Drain	

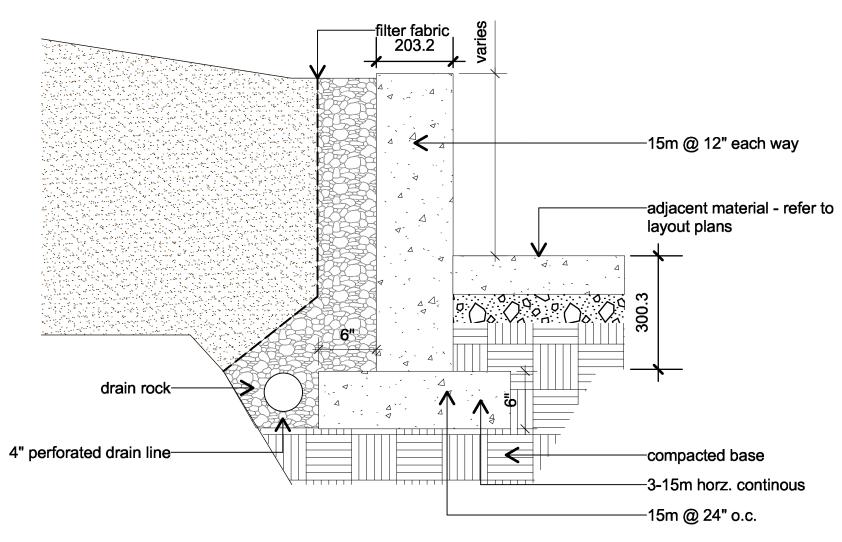

Depth 10 Cubic Meter - Soil Volume 5 Cubic Meter - Soil Volume SQUARE Size of Surface CIRCLE Size of Surface SQUARE Size of Surface CIRCLE Size of Surface Growing Medium Subgrade (mm) Area (m2) 3.80 M Ø 450 22.10 4.7m x 4.7m 7.05 M Ø 3.3m x 3.3m 600 16.80 4.1m x 4.1m 5.17 M Ø 8.33 2.9m x 2.9m 3.25 M Ø 13.70 6.67 750 3.7m x 3.7m 4.36 M Ø 2.6m x 2.6m 2.90 M Ø

Remove any soil on top of

"original" rootball.

GRANULAR SURFACING - ON GRADE L3.01 | Scale = 1:10


CIP PLANTER - ON GRADE

CIP CONCRETE - ON GRADE

3.01 Scale = 1:10

TYPICAL TREE PLANTING

Varies with depth of rootball

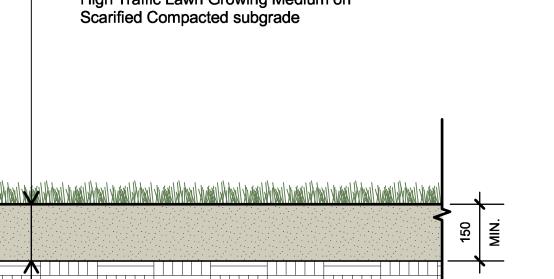

Revisions:

Stamp:





RECEIVED **DP1392** 2025-JUL-16 Current Planning

Project:

3397 Tunnah Road

3397 Tunnah Road, Nanaimo, **V9T 2V8**

Drawn by: SV Checked by: Date: 2025-04-28 AS SHOWN Scale:


DETAILS

Drawing Title:

Project No.: 25025

Sheet No.:


L-4.01

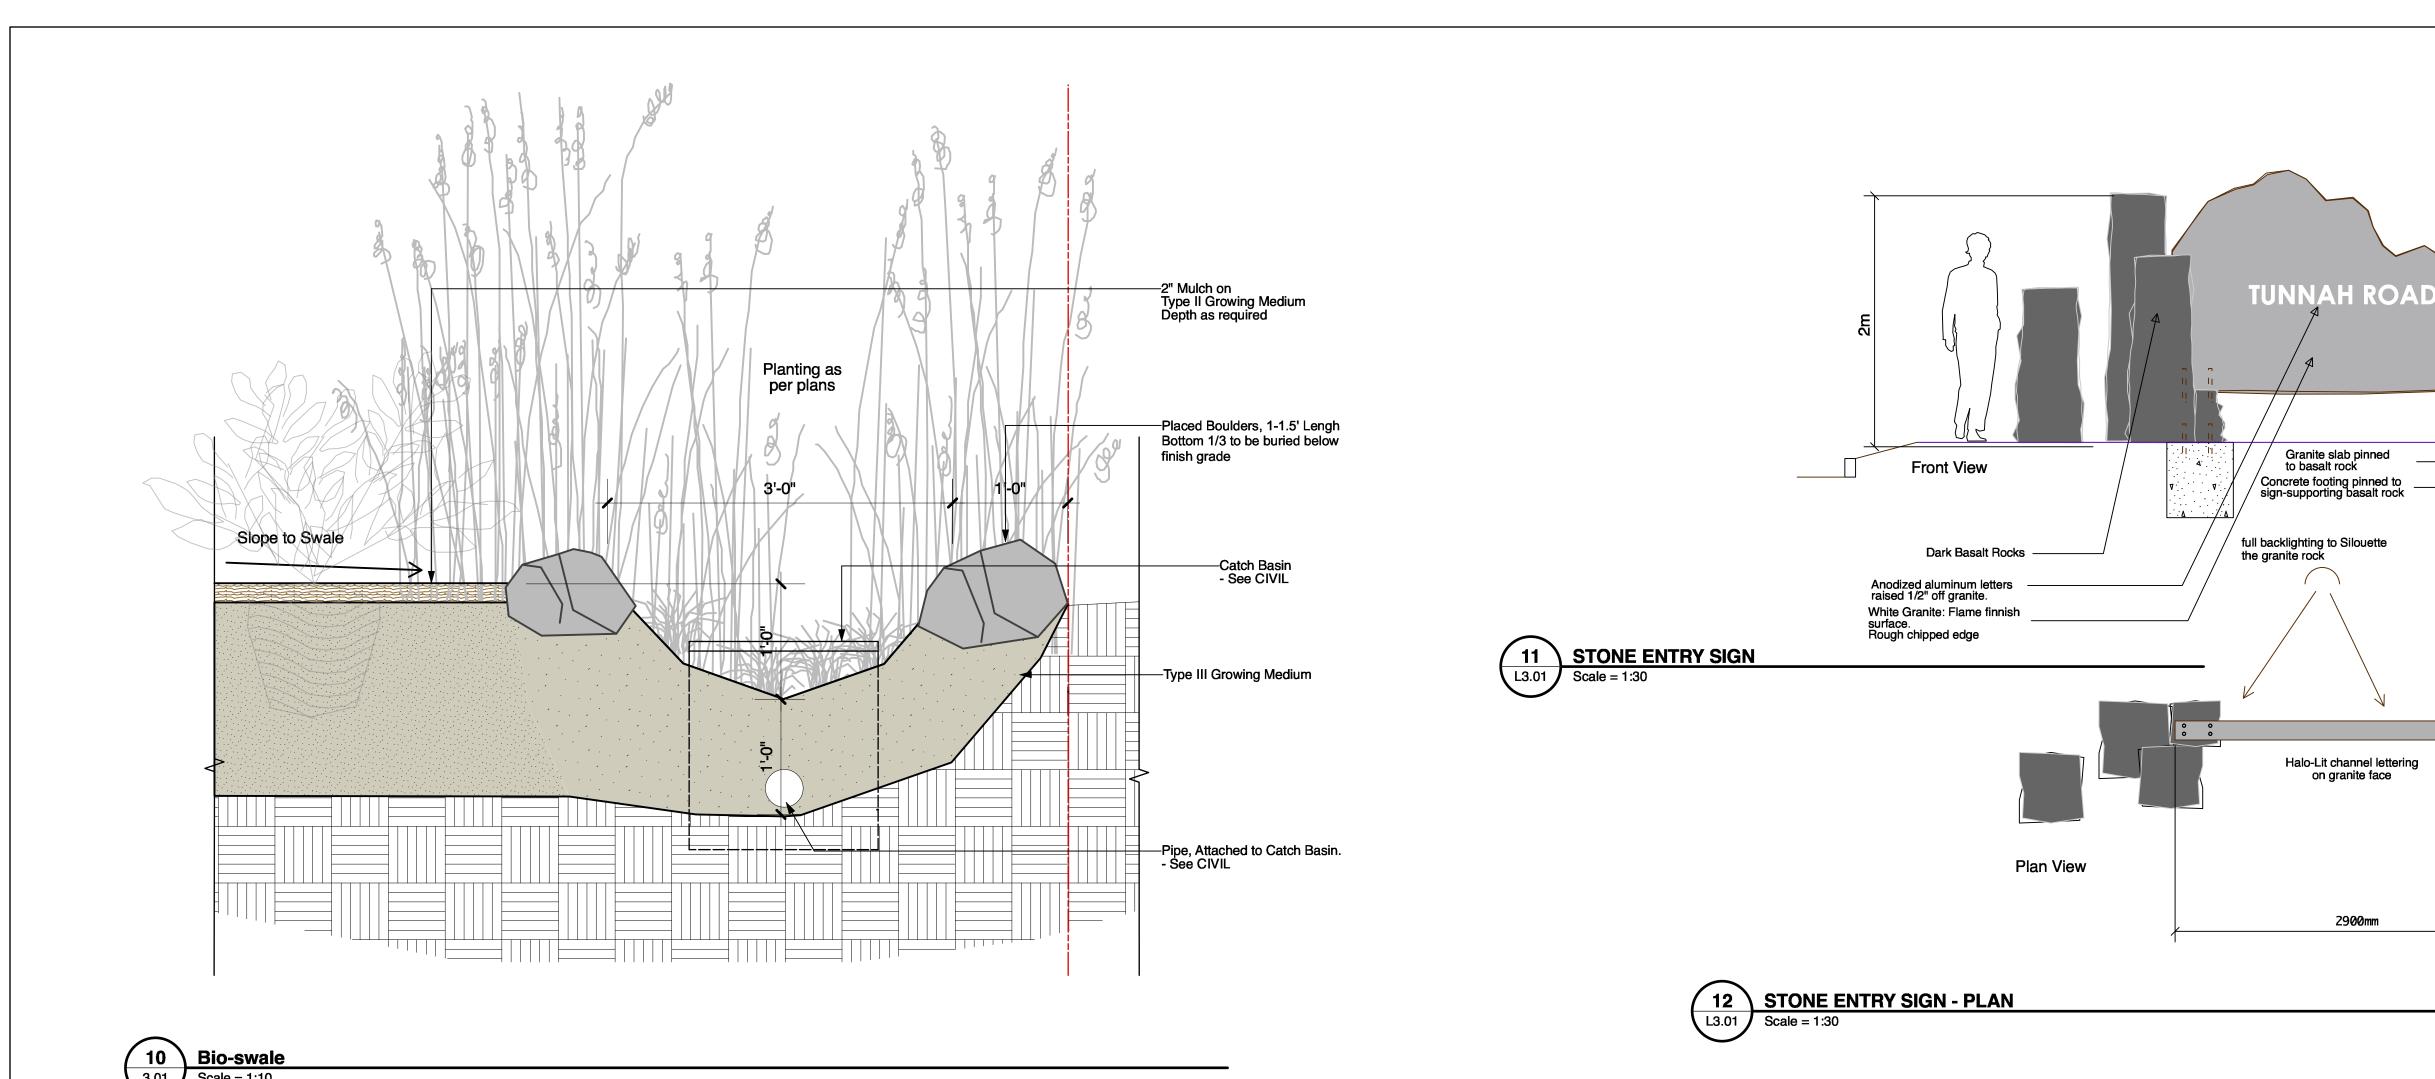


14 TYPICAL ALUMINUM FENCE
L3.01 Scale = 1:10

Cast in place sleeve welded to post, or core drill. Epoxy grout in place.
Pipe sleeve to extend minimum 1'-0" into top of footing. See detail Ld-x for footing detial.

13 TYPICAL ALUMINUM GATE
L3.01 Scale = 1:10

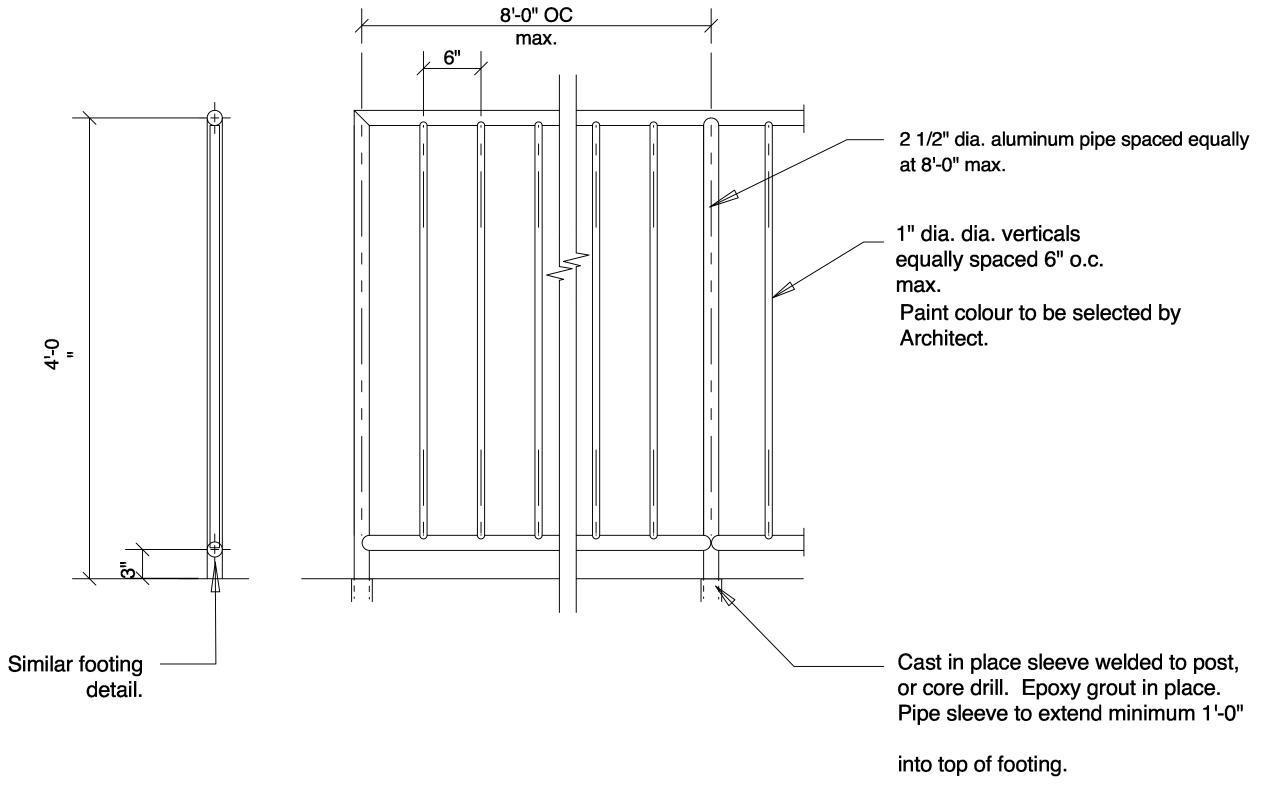

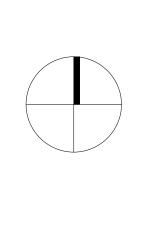

2	2025-07-08	Issue for DP	MP
1	2025-07-04	Issue for DP Draft	MP
no.:	date:	item:	by:

Revisions: Stamp:





Client:

RECEIVED **DP1392** 2025-JUL-16 Current Planning

Project:

3397 Tunnah Road

3397 Tunnah Road, Nanaimo, **V9T 2V8**

Drawn by:	MP
Checked by:	SV
Date:	2025-04-28
Scale:	AS SHOWN


Drawing Title:


DETAILS

Project No.: 25025


Sheet No.:

L-4.02

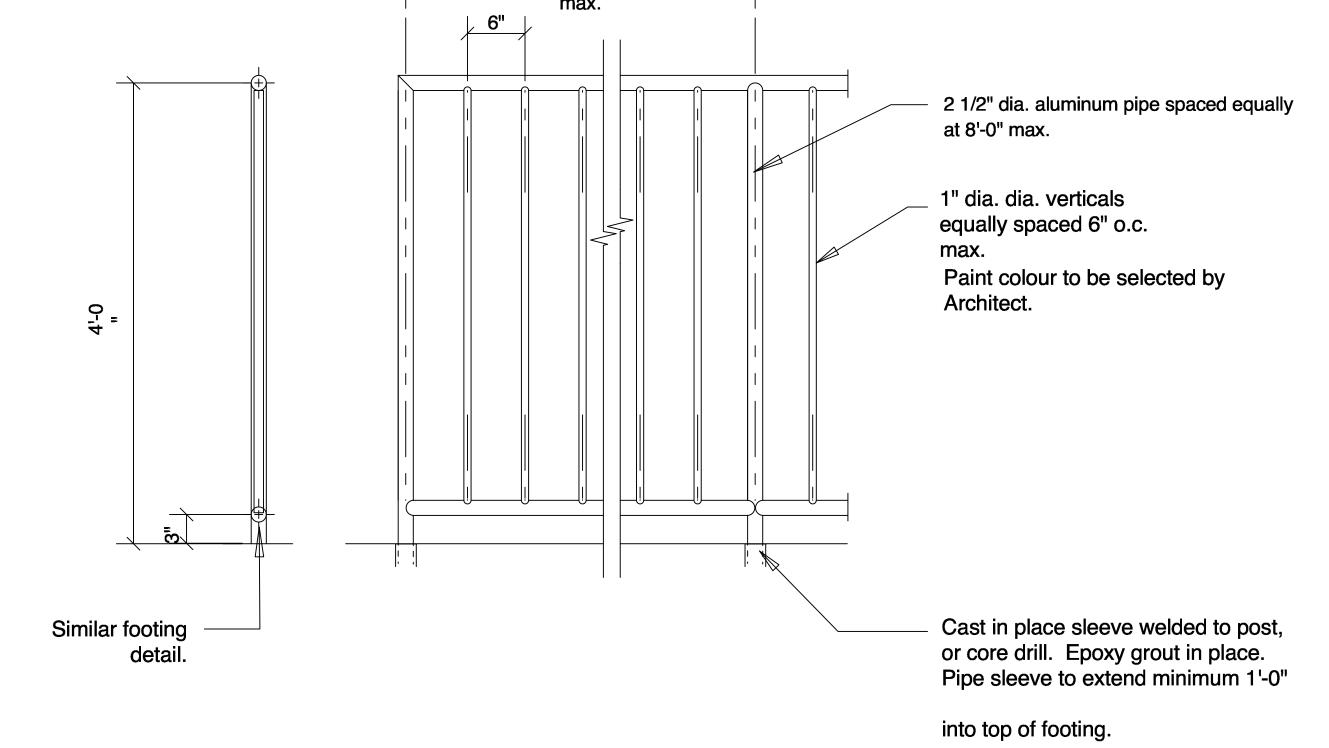

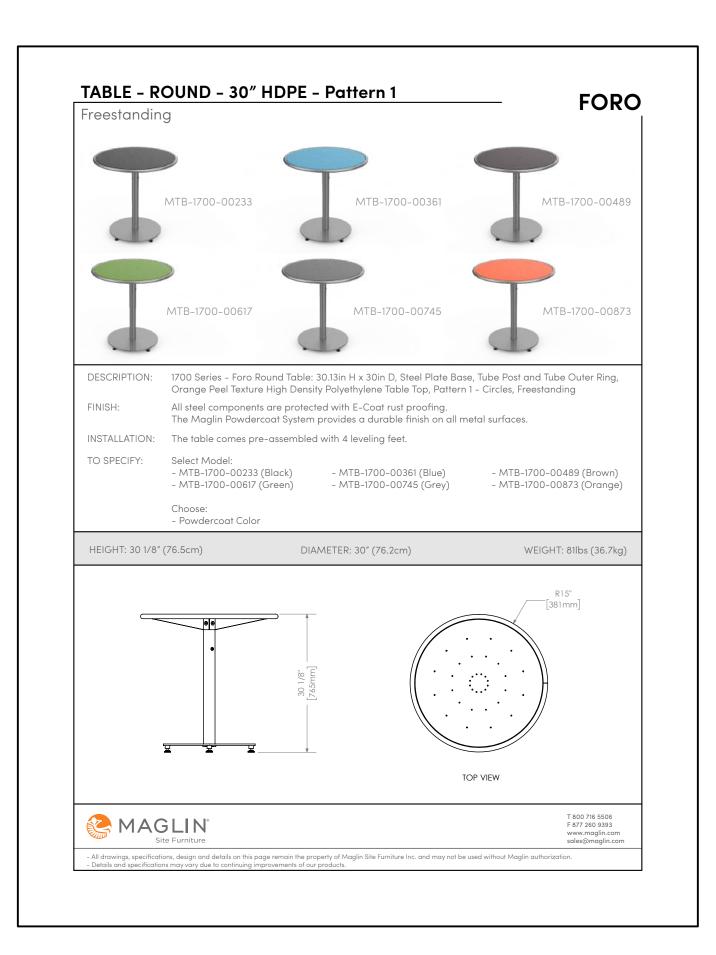




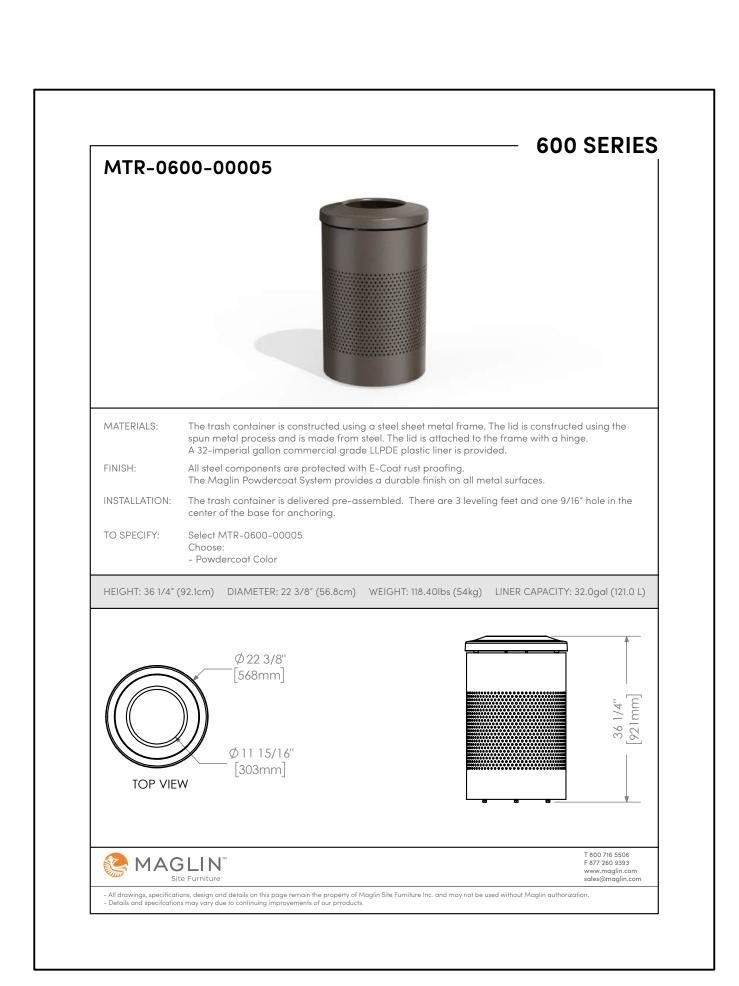








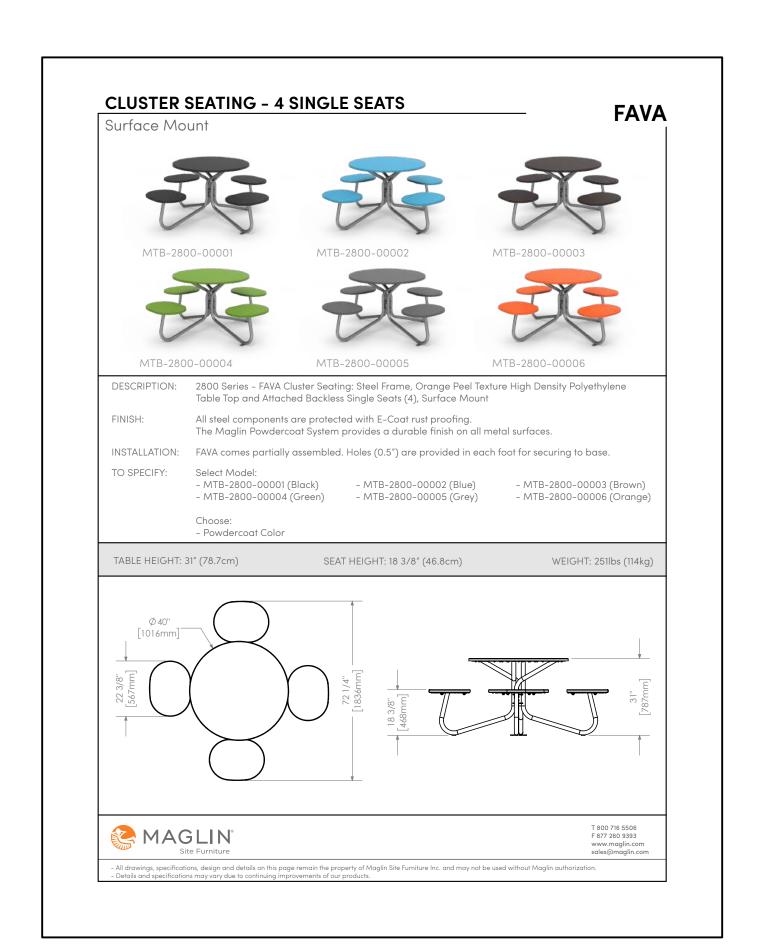



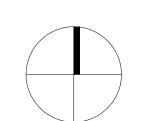

2 2025-07-08 Issue for DP MP
1 2025-07-04 Issue for DP Draft MP
no.: | date: | item: | by:
Revisions:

Stamp:





P 604.084.4611 | F 604.084.0577 | www

Client:

RECEIVED
DP1392
2025-JUL-16
Current Planning

Project:

3397 Tunnah Road

3397 Tunnah Road, Nanaimo, BC V9T 2V8

Drawn by: MP

Checked by: SV

Date: 2025-04-28

Scale: AS SHOWN

Drawing Title:

DETAILS

Project No.: 25025

Sheet No.:

L-4.03